
MOTIVATE

5518 FRANKLIN AVE | HOLLYWOOD, CA 90028

VERMONT WESTERN STATION NEIGHBORHOOD AREA PLAN (SNAP)

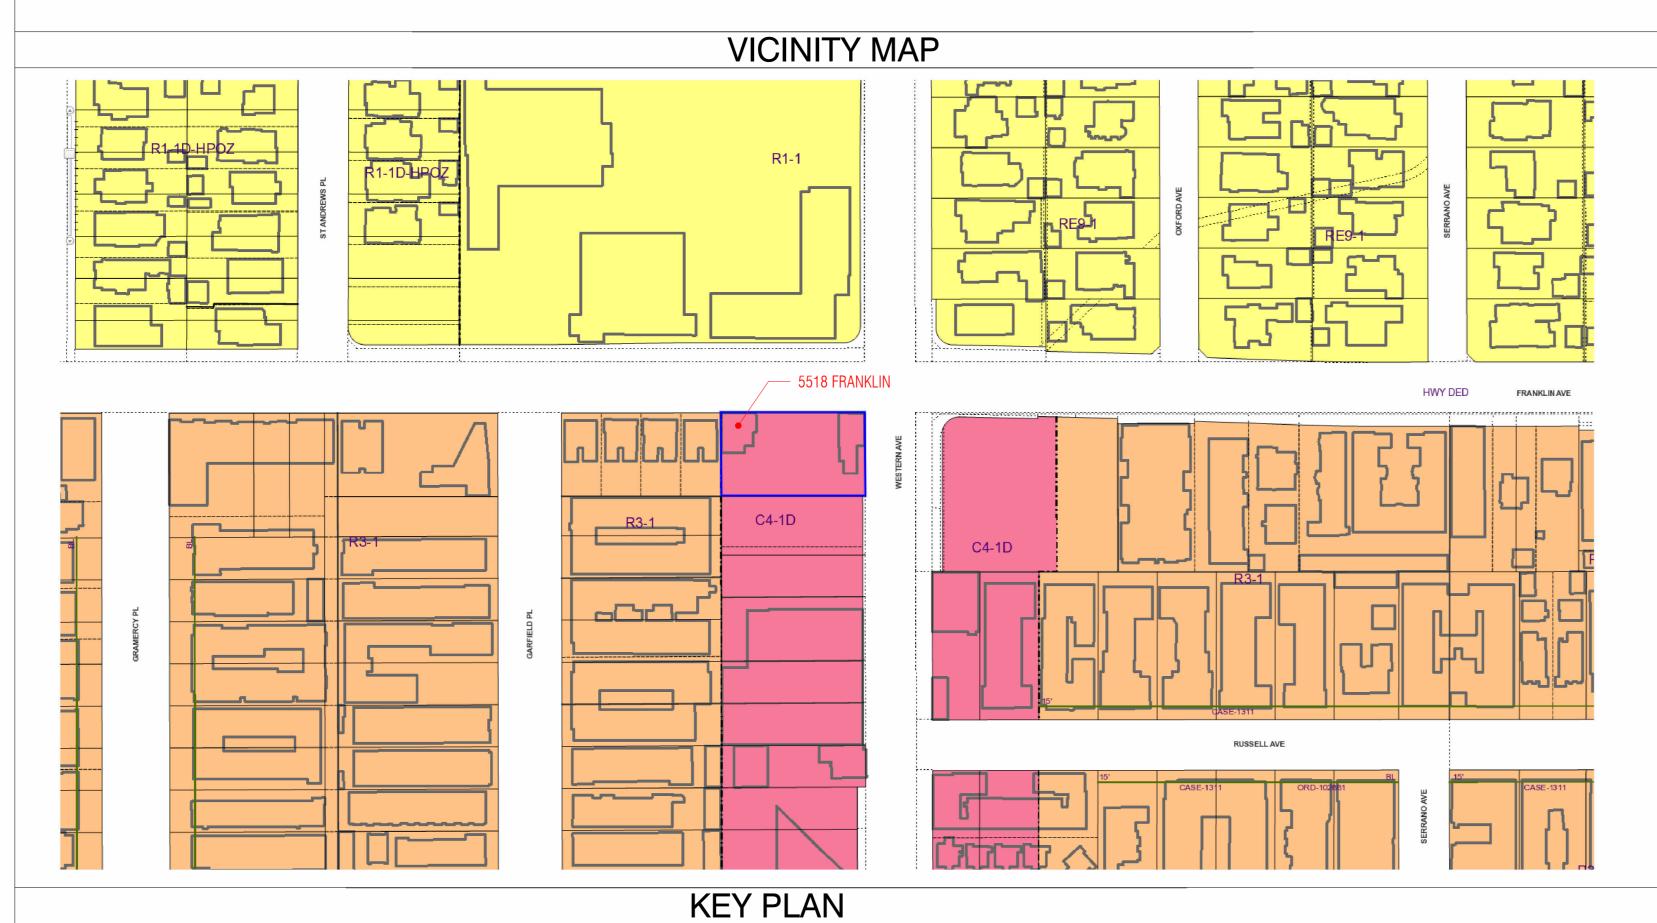

DIGITAL CATANGEMENT OF BLUE OF BEAUTY OF BEAUTY

PROJECT INFORMATION PROJECT ADDRESS: 5518 FRANKLIN AVE, HOLLYWOOD CA LEGAL ADDRESS: LOT 1 OF TRACT 63625-C MAP BOOK 1384 PAGE 1 OF 4 THE SCOPE OF THIS SUBMISSION CONSISTS OF COMMERCIAL TENANT IMPROVEMENT OF 1537 SF PROJECT DESCRIPTION: OF A GROUP CARDIO GYM. CHANGE OF USE FROM DRY CLEANER TO GYM TYPE OF CONSTRUCTION: BUILDING OCCUPANCY: RENTABLE AREA: AREA IN SCOPE: 537 SF (INTERIOR TENANT IMPROVEMENT) BUILDING NO. OF STORIES: SINGLE STORY STAND-ALONE BUILDING PROJECT LOCATION: MEP, VISUAL AND AUDIBLE ALARMS, AND OTHER FIRE PROTECTION ITEMS BUILDING LIFE SAFETY INFO: SPRINKLERS, VISUAL AND AUDIBLE ALARMS NOT PROVIDED THE CONTRACTOR SHALL REPLACE ALL MISSING FIREPROOFING AND THE CONTRACTOR SHALL REPLACE ALL FIREPROOFING AFFECTED BY NEW CONSTRUCTION WITH FIREPROOFING TO MATCH BASE BUILDING STANDARDS, APPROVED EQUAL, OR AS REQUIRED TO MATCH THE EXISTING. 2. ALL INTERIOR FINISHES SHALL COMPLY WITH THE REFERENCED CODE FLAMMABILITY AND SMOKE DEVELOPED RATINGS AS WELL AS TOXICITY. WALL AND CEILINGS: PER ASTM E84, CLASS A FLAME SPREAD: 0 - 25 SMOKE DEVELOPMENT: 0 - 200 FLOORING: ASTM E648, CLASS I CRITICAL RADIANT FLUX OF NOT LESS THAN 0.45 WATTS PER 3. ALL DOORS TO BE 36" WIDE MIN., 34" MIN. CLR. IN OPEN POSITION

ZONING INFORMATION		
ZONING	C4-1D (Subarea B of the SNAP - C1.5)	
PROPERTY TYPE	GYM	
APN	5544004035	
FIRE SPRINKLER	NO	
AREA IN SCOPE	1740 SF	
TYPE OF	IIIB	
CONSTRUCTION		
NUMBER OF STORIES	1	
VERY HIGH FIRE	NO	
HAZARD SEVERITY		
ZONE		
BLDG LEGAL ADDRESS	LOT 51 OF HOLLYWOOD TERRACE TRACT MAP BOOK M B 3-98	
LOT AREA (SF)	17,004.5	

BUILDIN	G INFORMATION (NO CHA	INGE AT EXTERIOR)
	EXISTING	PROPOSED
Building Area (SF)	1740	1740
FAR	0.1:1	0.1:1
HEIGHT	17'-8"	17'-8"

	SHEET INDEX				
	SNAP SHEET LIST				
Sheet Number	Sheet Name				
GN-1.0A	PROJECT INFORMATION				
GN-2.0	PLOT PLAN				
GN-2.4	(E) PARKING ANALYSIS (FOR REFERENCE ONLY)				
GN-2.7	EXISTING PHOTOS				
A-1.0	EXISTING & PROPOSED PLAN				
A-3.0	EXTERIOR ELEVATIONS				
A-4.0	ROOF PLAN				

ARCHITECT	CLIENT/TENANT	STRUCTURAL ENGINEER	OWNER REP
STUDIO 3AM NUO LIU-HOGAN, AIA 5665 W. WILSHIRE BLVD #1139 .OS ANGELES, CA 90036 323-868-3187 / EVA@STUDIO0300.COM	MOTIVATE STUDIO CEREZA RICHESON 213.925.7164/cerezaricheson@gmail.com	A-S ENGINEERS JOE FLEISCHER 310.908.3446/joefleischer@hotmail.com	CGI PLUS DAVID ESTRADA 818.438.0467/DEstrada@CGIPlus.com
NGINEER GINEERING JFIGHI, P.E. SMYTH DR. ST 104 CIA, CA 91355 54.7496/aceng@sbcglobal.net			

	APPLICABLE CODES
2020 LOS ANGELES BUILDING CODE	
2020 LOS ANGELES FIRE CODE	
2020 CALIFORNIA ENERGY CODE	
2020 LOS ANGELES MECHANICAL CODE	
2020 LOS ANGELES PLUMBING CODE	
2020 LOS ANGELES ELECTRICAL CODE	
2020 LOS ANGELES GREEN BUILDING STANDARDS C	CODE



MOTIVATE GYM

TENANT IMPROVEMENT





2 3 SNAP CLEARANCE 1 PLAN CHECK SUBMITTAL 1

8/14/2023 6/1/2023

 Delta
 Issue
 Description
 Date


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 Checker

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 Check
 Owner Approval


 MOTIVATE STUDIO
 1/32" = 1'-0"

PROJECT
INFORMATION
Title
GN-1.0A

1/32" = 1'-0"

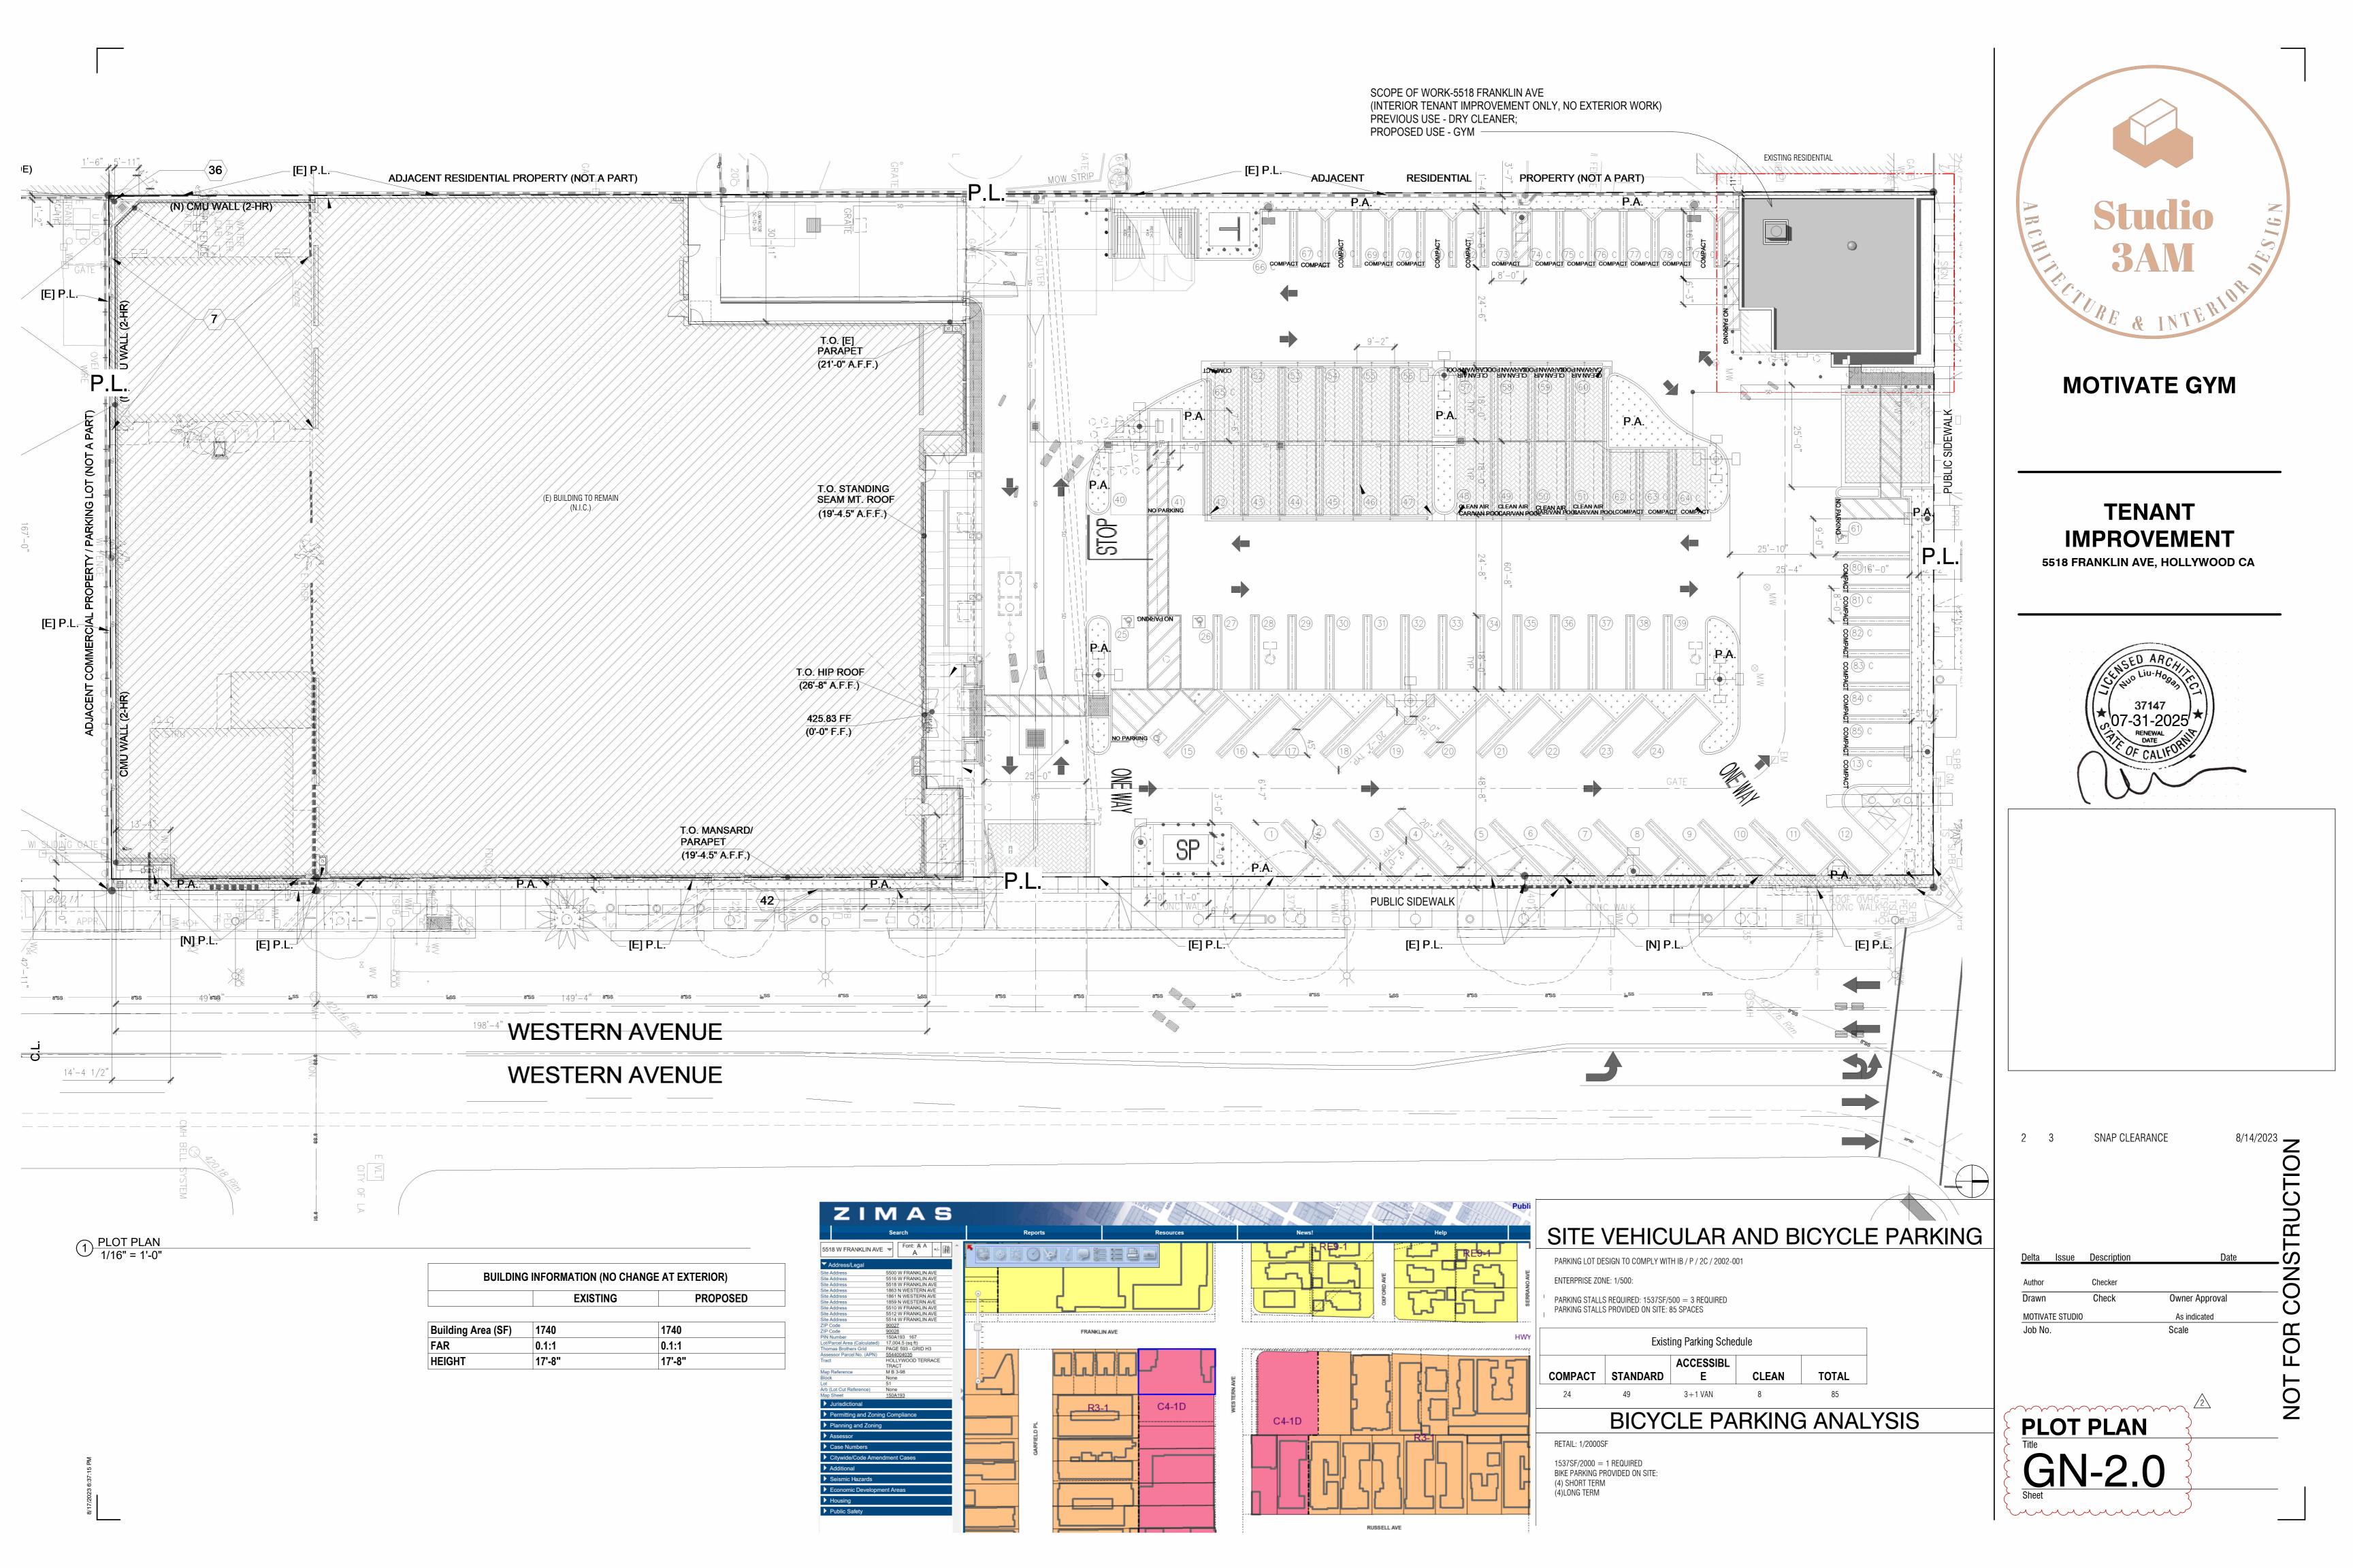

PARKING PLANS WERE CHECKED UNDER PERMIT #: 20014 - 30000 - 04179

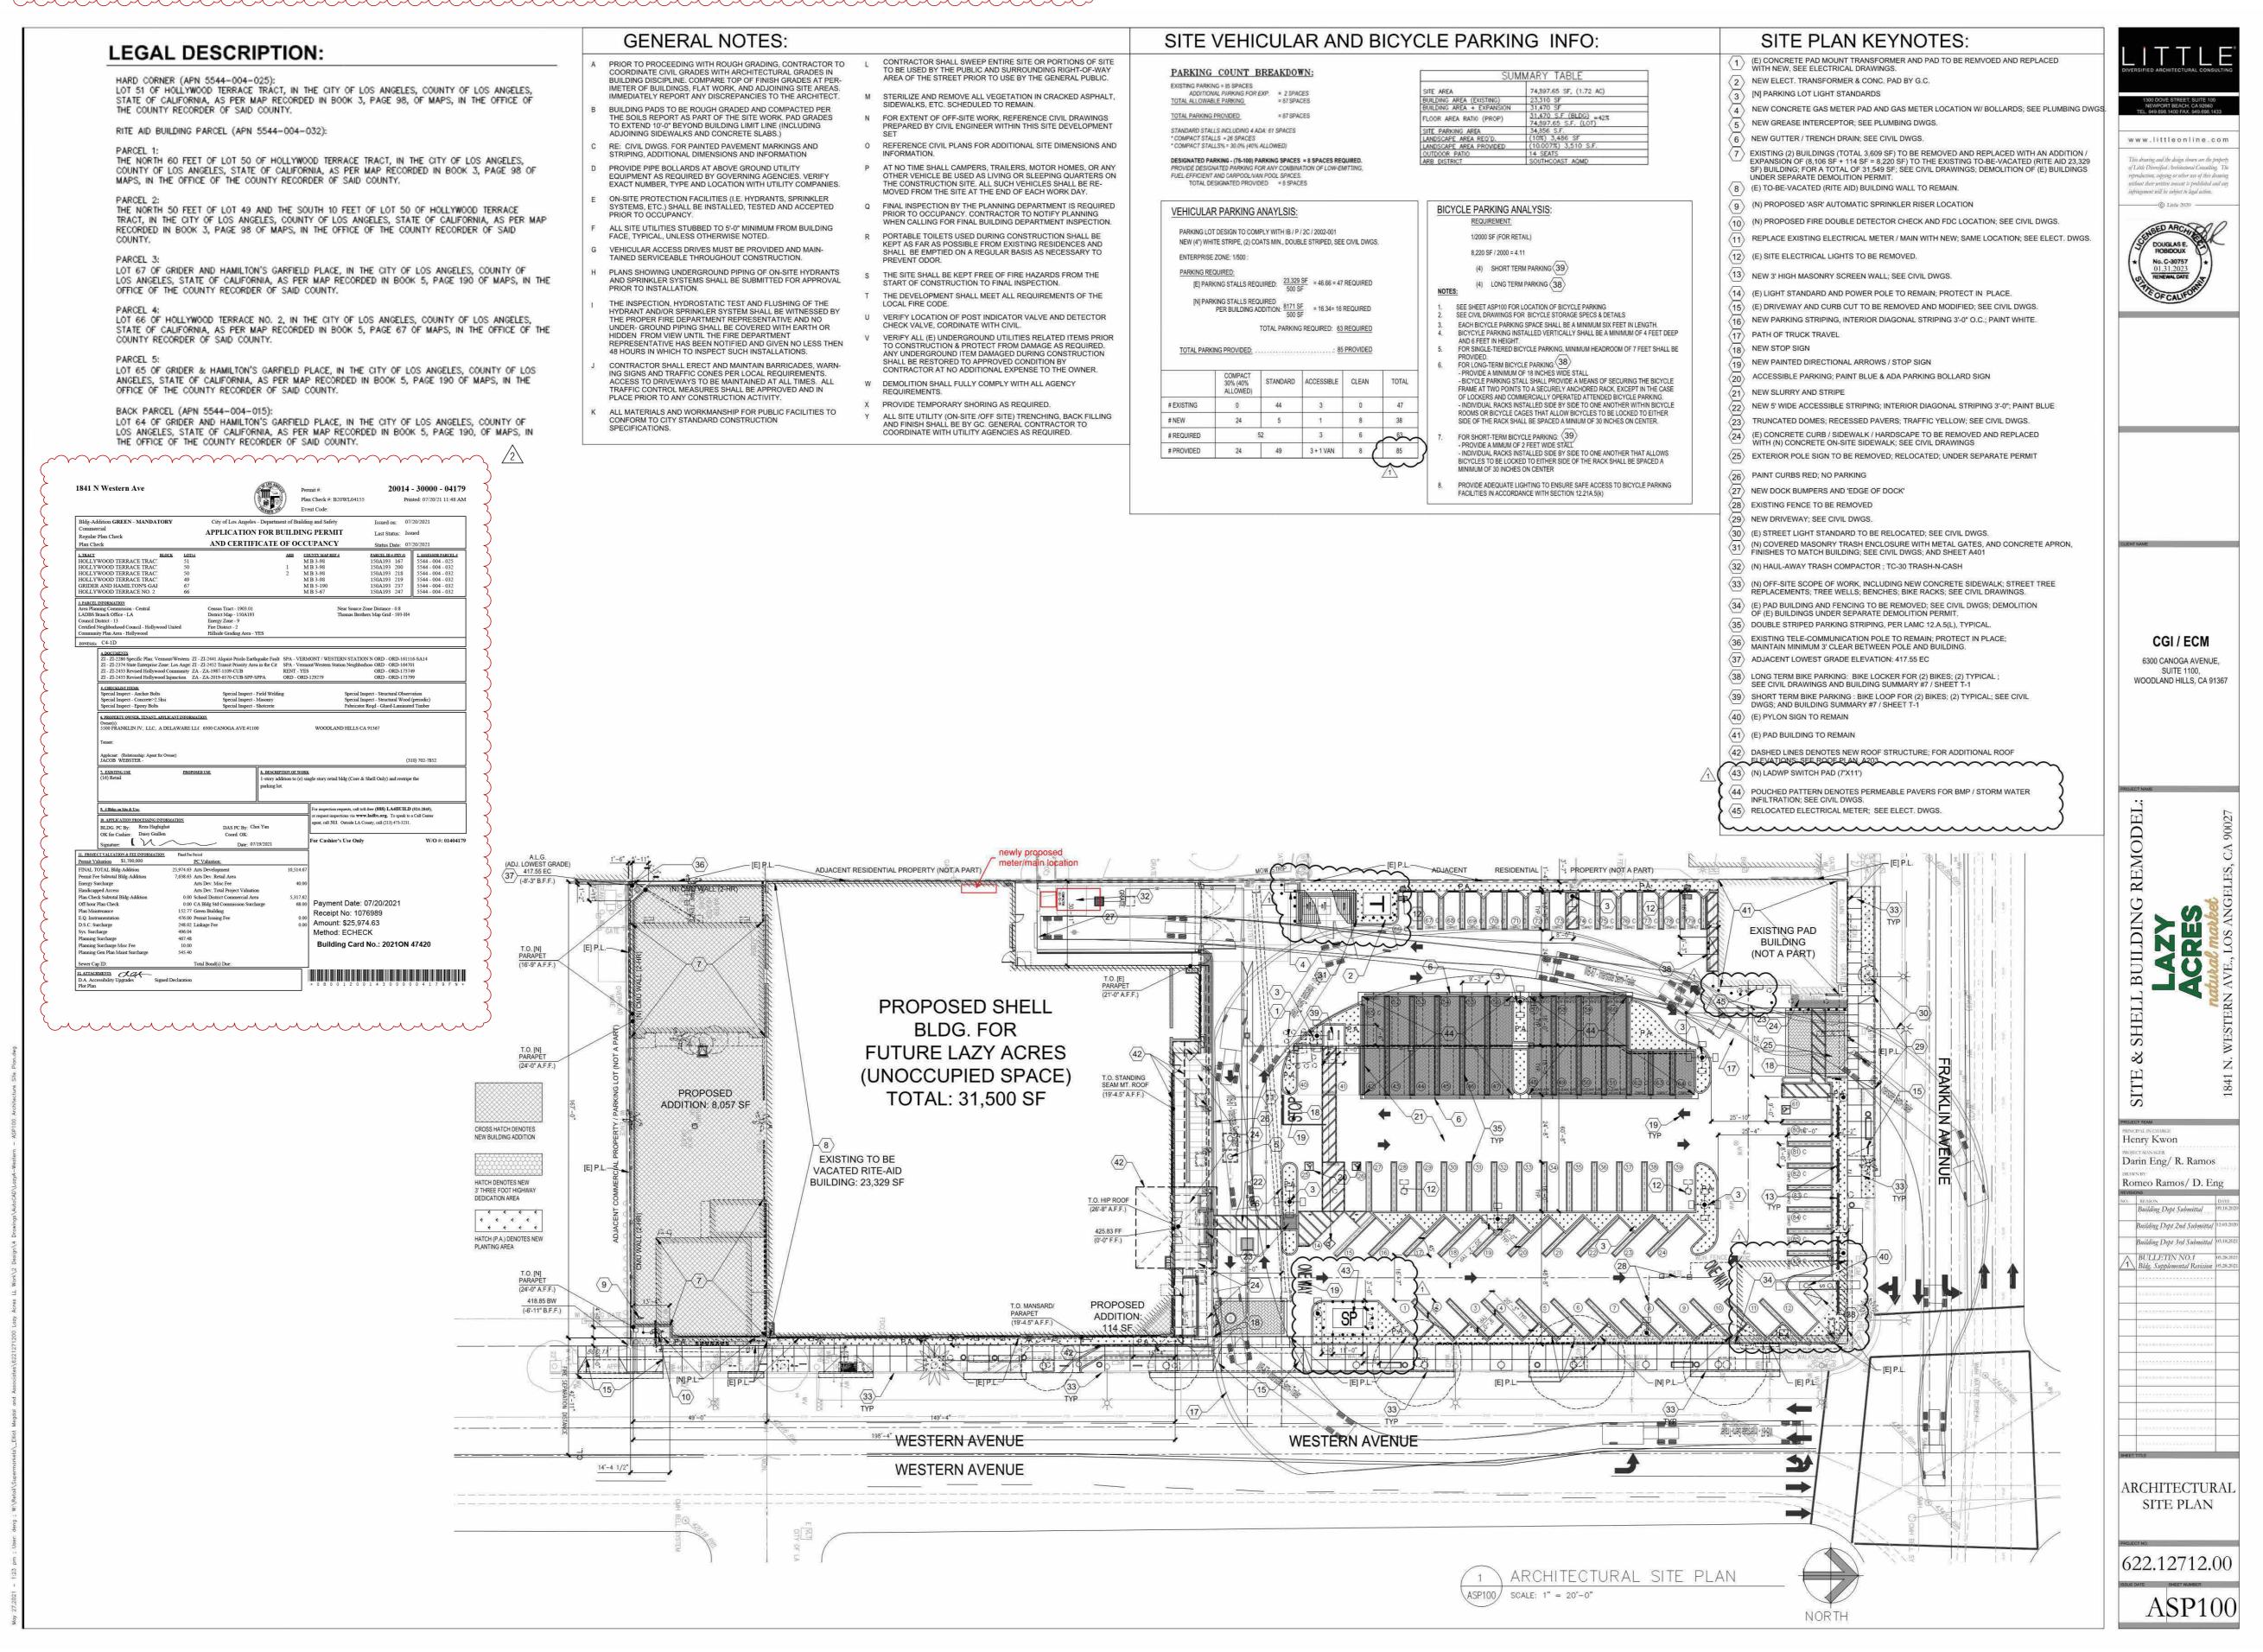



MOTIVATE GYM

TENANT IMPROVEMENT 5518 FRANKLIN AVE, HOLLYWOOD CA



}	SNAP CLEARANCE	8/14/2023
)	PLAN CHECK CORRECTION	7/10/2023
-	DELTA 1	1710/2020
	PLAN CHECK SUBMITTAL 1	6/1/2023
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Issue	Description	Date


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(E) PARKING
ANALYSIS (FOR
REFERENCE ONLY)


GN-2.4


Delta

MOTIVATE STUDIO



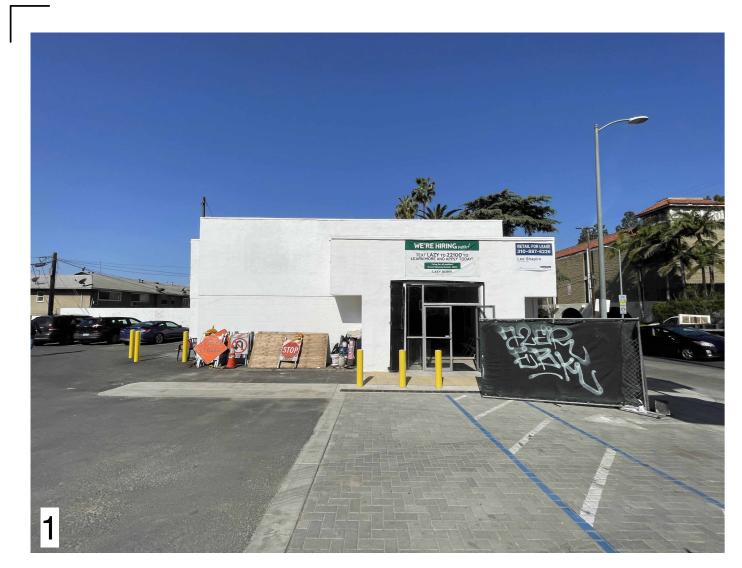

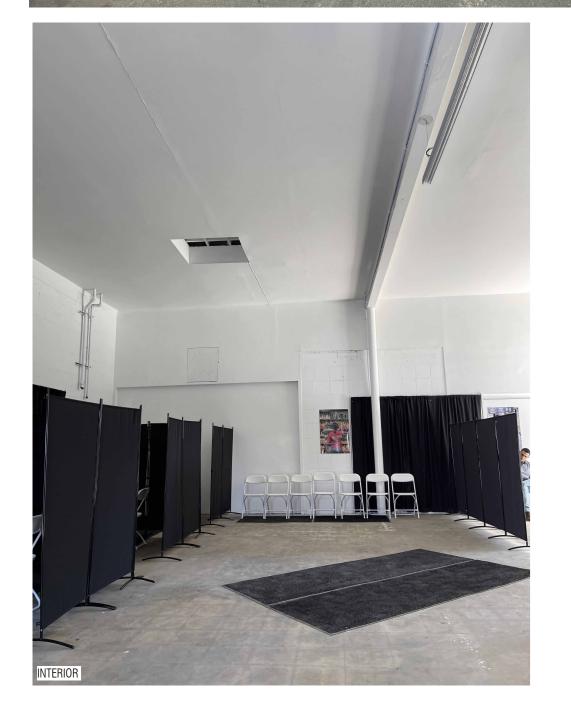

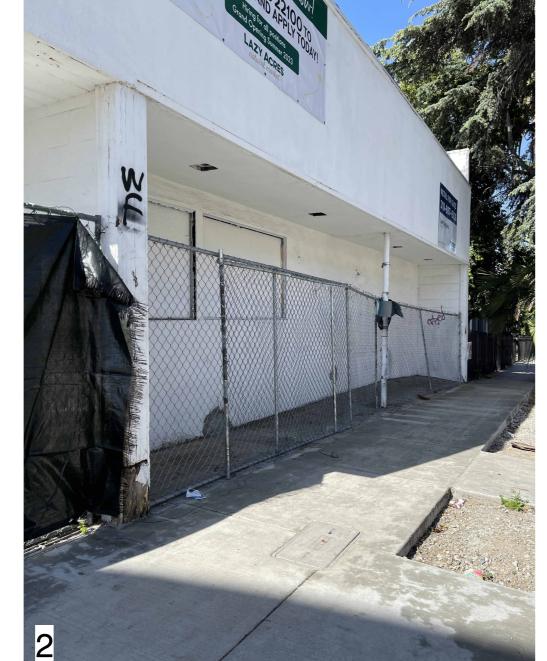





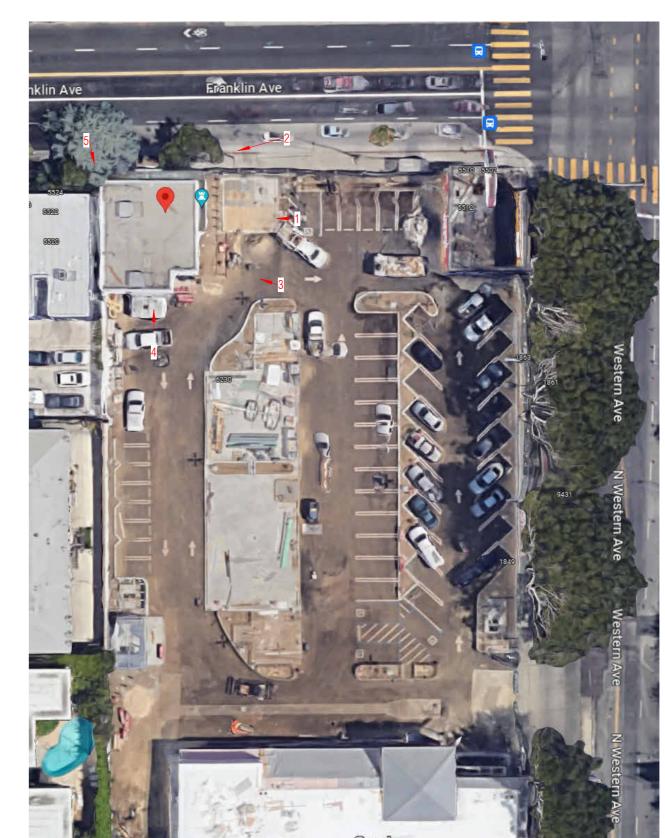


PHOTO KEYPLAN



MOTIVATE GYM

TENANT IMPROVEMENT 5518 FRANKLIN AVE, HOLLYWOOD CA



2 3 SNAP CLEARANCE

Issue Description Date

Checker
Check Owner Approval


Author Checker

Drawn Check Owner Approva

MOTIVATE STUDIO

Job No. Scale

EXISTING PHOTOS
Title
GN-2.7
Sheet

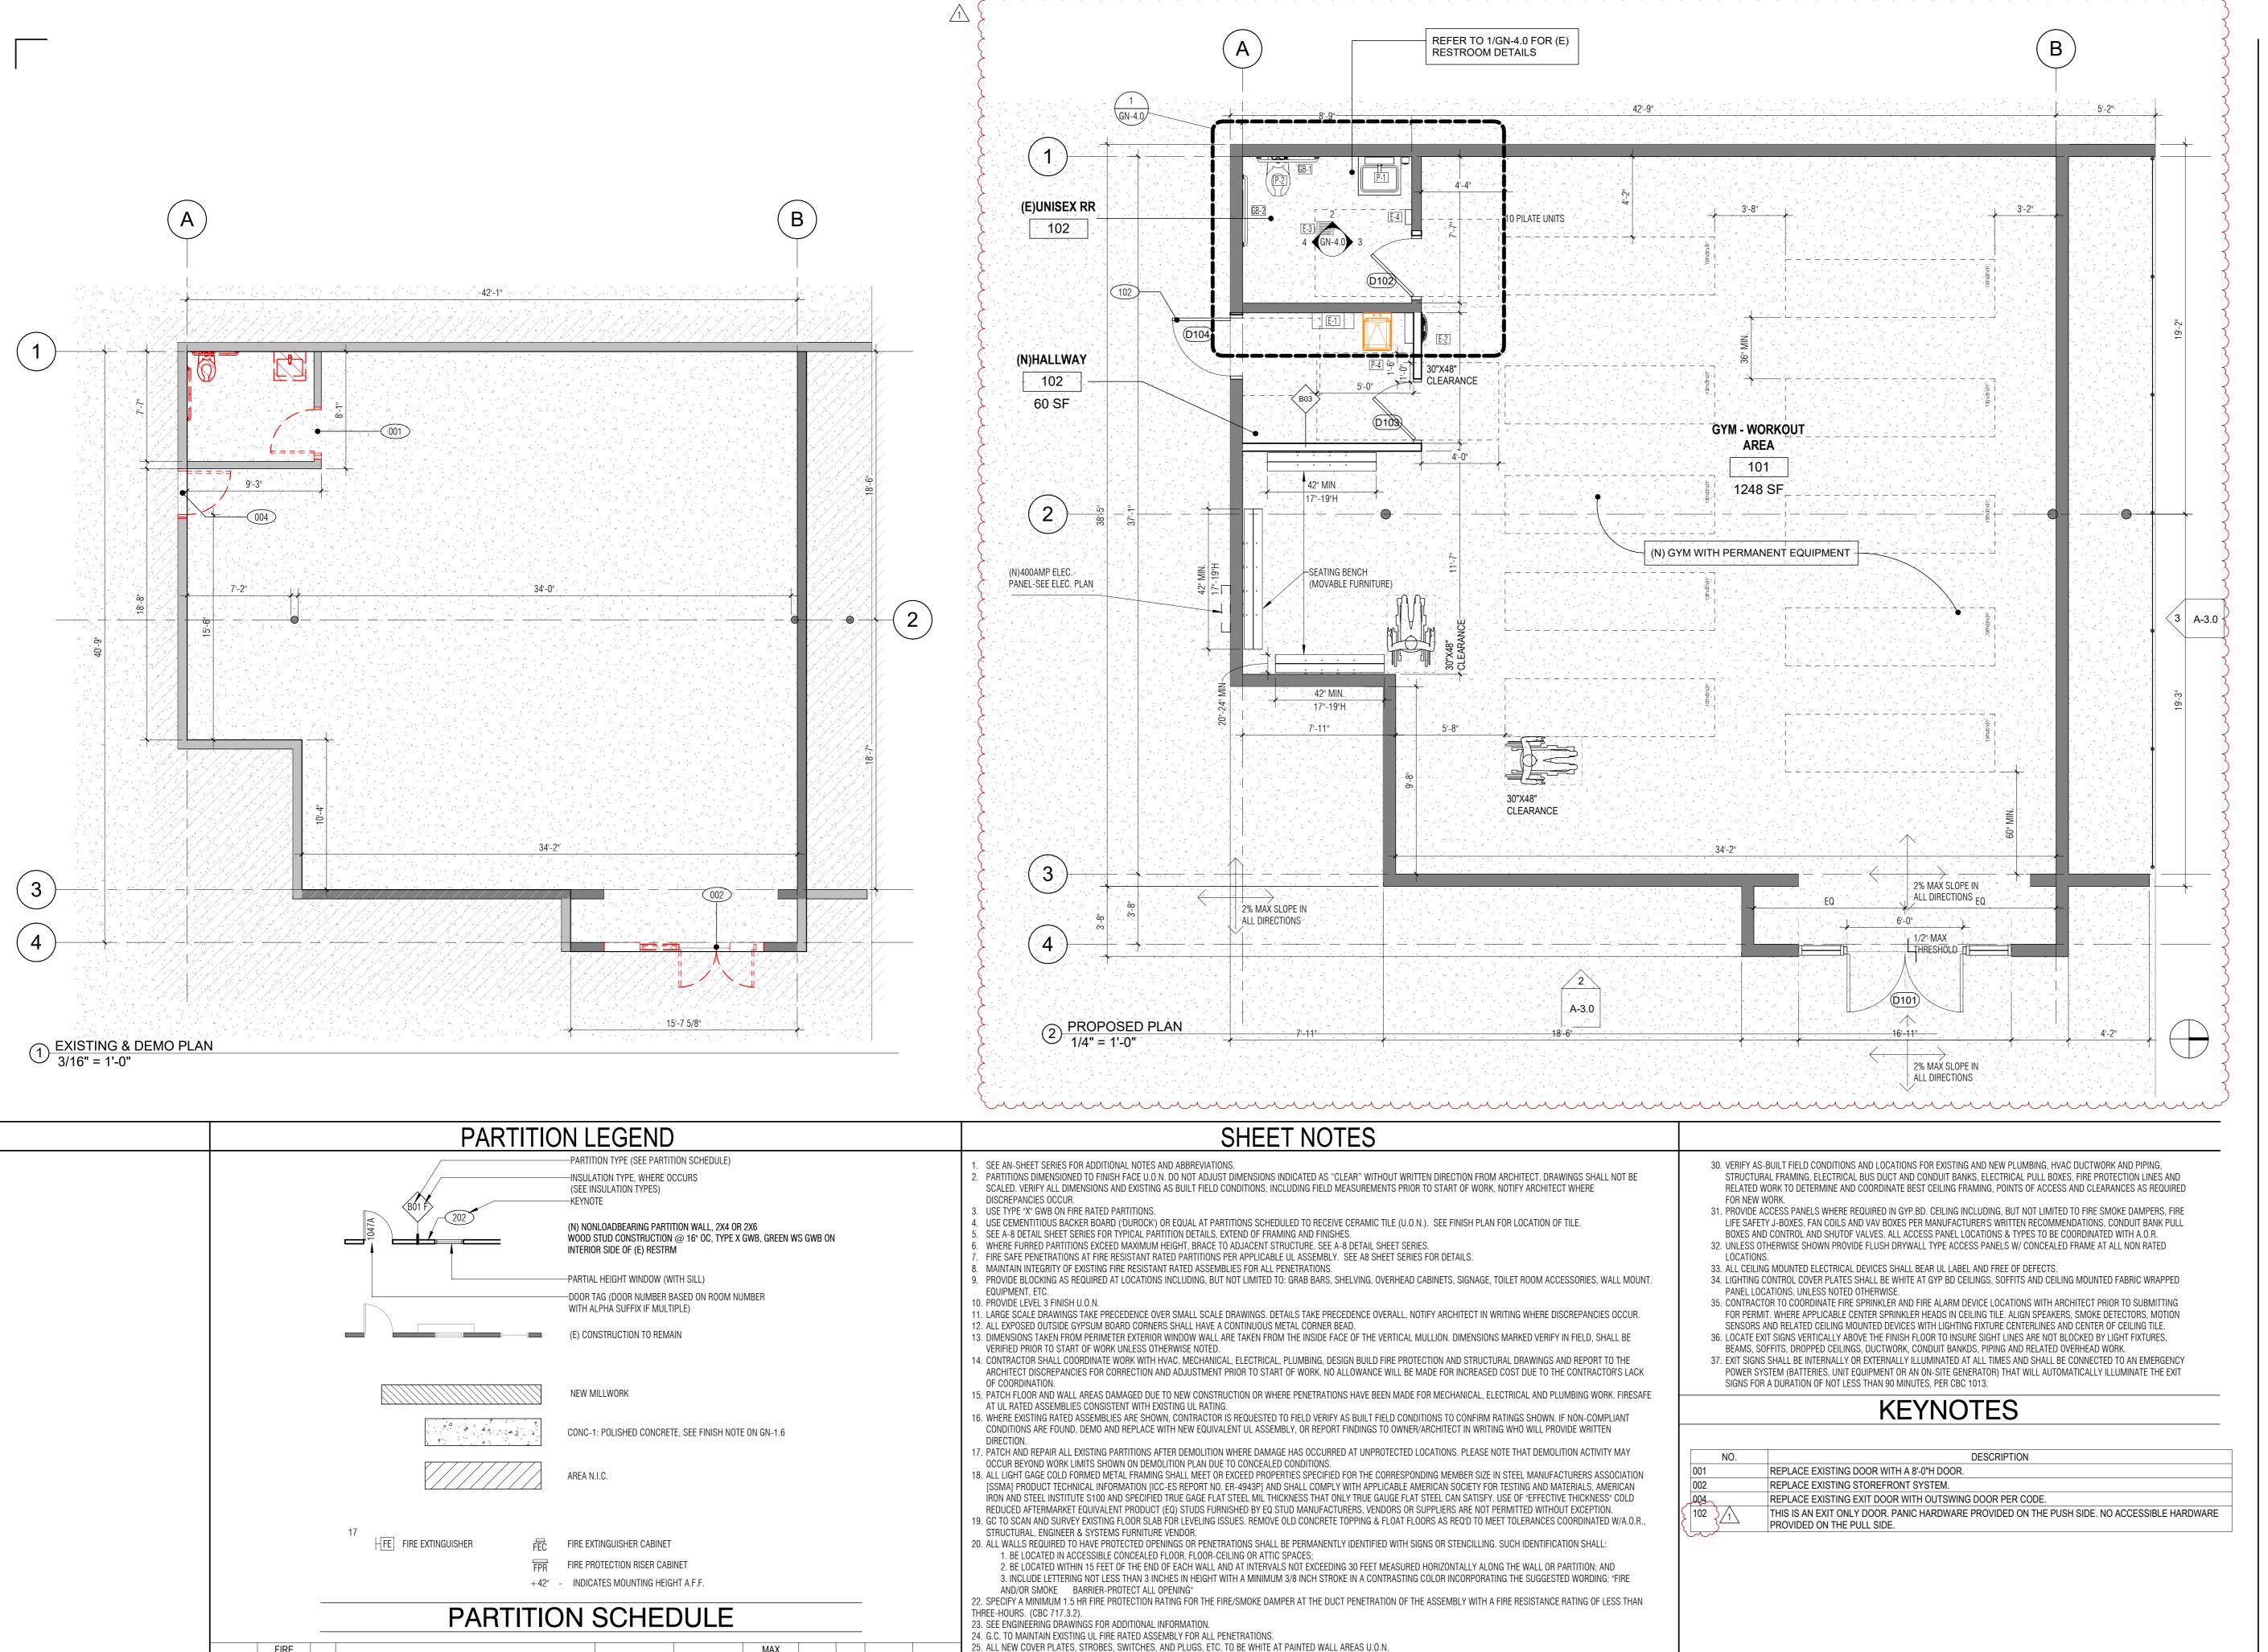

26. WHERE DEVICES ARE SHOWN BACK TO BACK, OFFSET AS REQUIRED TO COMPENSATE FOR BOX AND STUD DIMENSIONS. USE CENTER POINT BETWEEN DEVICE LOCATIONS AS

BASIS. REESTABLISH ALL BUILDING SERVICES AND UTILITIES AT CONCLUSION OF TEMPORARY SHUT OFF, AS SOON AS PRACTICAL.

27. FOR DEDICATED OUTLETS AND RECEPTACLE MOUNTING HEIGHTS DESIGNED FOR SPECIAL EQUIPMENT, HEIGHT SHALL BE MEASURED FORM THE FINISHED FLOOR TO THE CENTERLINE

28. ALL ELECTRICAL WORK AND MATERIALS SHALL BE IN COMPLIANCE WITH THE CURRENT RULES AND REGULATIONS OF THE NATIONAL BOARD OF FIRE UNDERWRITERS, THE STATE FIRE MARSHALL, THE SAFETY ORDERS OF THE DIVISION OF INDUSTRIAL SAFETY, DEPARTMENT OF INDUSTRIAL RELATIONS AND APPLICABLE CODES. ALL EQUIPMENT SHALL BE UL LABELED. 29. BUILDING SERVICES AND UTILITY DISRUPTIONS TO THE BUILDING, INCLUDING ADJACENT TENANTS IN MULTI-TENANT BUILDINGS ARE NOT PERMITTED DURING NORMAL BUSINESS HOURS. ALL FIRE / LIFE SAFETY SYSTEMS SHALL REMAIN OPERATIONAL DURING DEMOLITION AND CONSTRUCTION ACTIVITIES DURING NORMAL BUSINESS HOURS. FOR TEMPORARY DISRUPTIONS LIMITED TO THE AREA OR WORK, AFTER HOURS AS NEEDED TO COMPLETE THE WORK, SCHEDULE DAY AND TIME WITH OWNER IN ADVANCE, IN WRITING ON AN OVERTIME

OF THE OUTLET MOUNTED VERTICALLY, UNLESS NOTED OTHERWISE. RECEPTACLE, SWITCH AND OUTLET MOUNTING HEIGHT DIMENSIONS ARE MEASURED FROM FINISHED FLOOR TO

RATING

(HR)

TYPE

STUD SPACING DEFLECTIO

SSMA#

362S125-33

NON-RATED 3 5/8" METAL STUDS, FULL HEIGHT

[SLAB-TO-SLAB] WITH ONE LAYER 5/8" GYPBOARD EACH SIDE.

THICKNES DETAIL

N MAX HT STC S REF.

L/240 | 16' - 5" | 40 | 0' - 4 7/8"

REFERENCE POINT FOR LOCATION DIMENSION U.O.N.

DUTLET CENTERLINE MOUNTED VERTICALLY, UNLESS NOTED OTHERWISE.



MOTIVATE GYM

TENANT IMPROVEMENT

5518 FRANKLIN AVE, HOLLYWOOD CA



1 2 PLAN CHECK CORRECTION 7/10/2023
DELTA 1
1 PLAN CHECK SUBMITTAL 1 6/1/2023

Delta Issue Description Date


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MOTIVATE STUDIO As indicated

Job No. Scale

EXISTING & PROPOSED PLAN

A-1.0



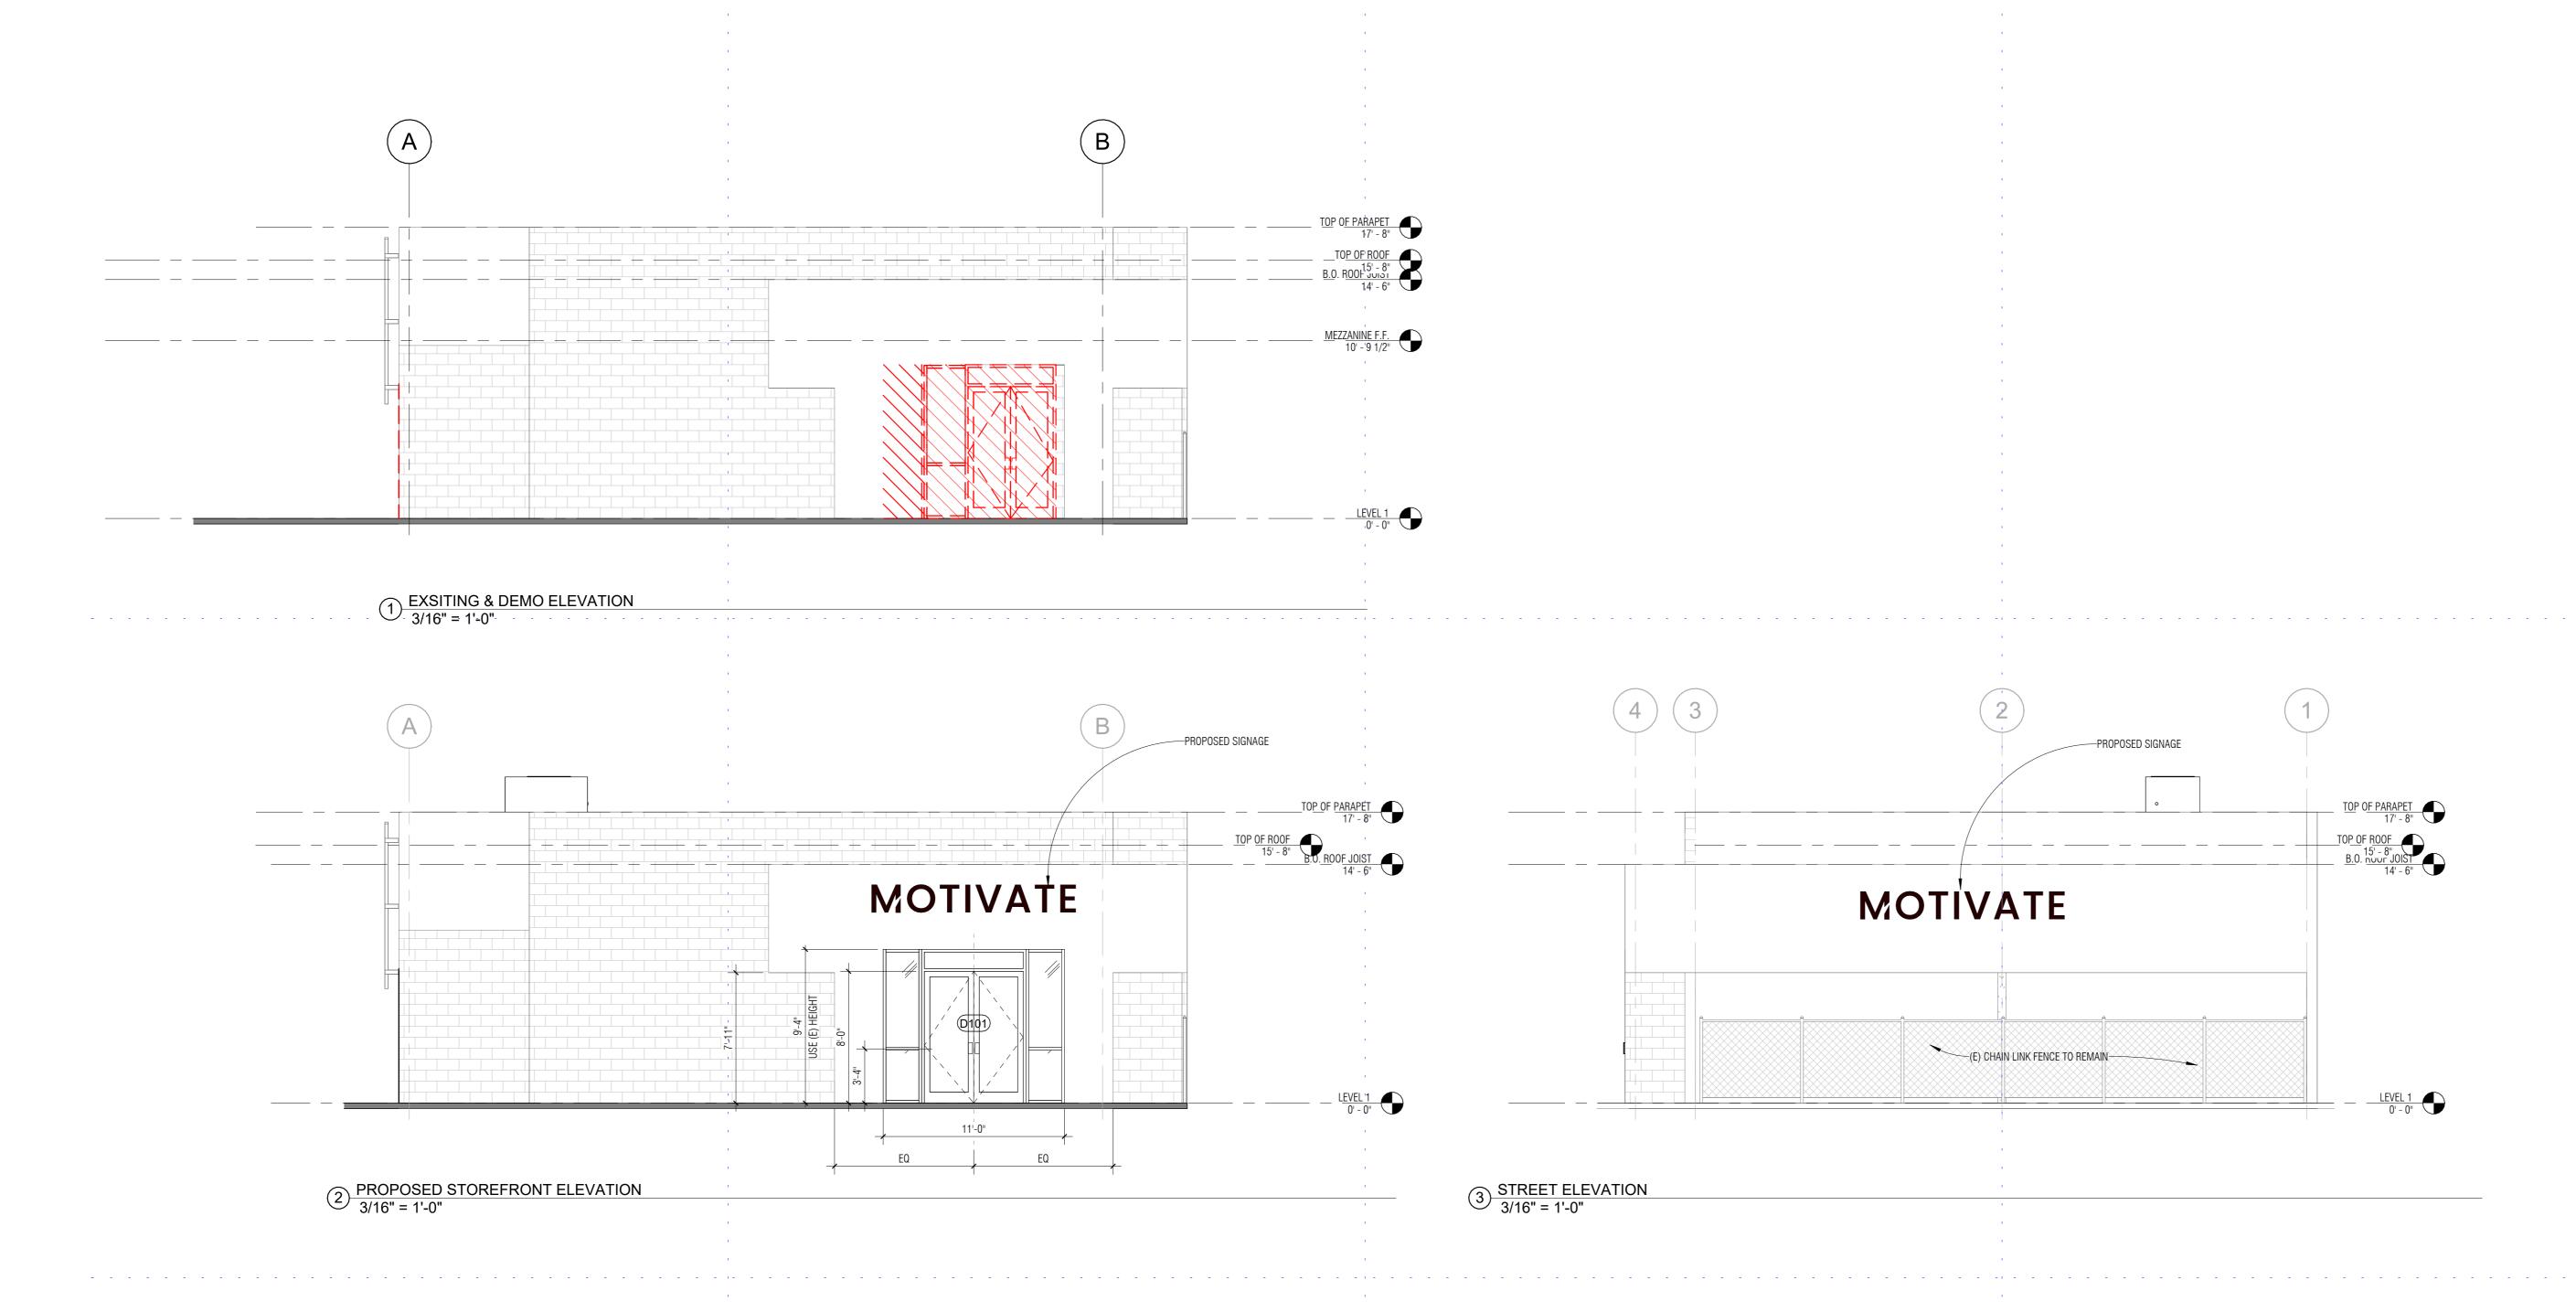

MOTIVATE GYM

TENANT IMPROVEMENT 5518 FRANKLIN AVE, HOLLYWOOD CA







Issue	Description	Ī	Date	I NSTRUCTIC
	Checker			
1	Check	Owner Approva	al	$-\mathcal{O}$
ATE STUDIO		3/16" = 1'-0"		
0.		Scale		_ B

EXTERIOR ELEVATIONS

A-3.(

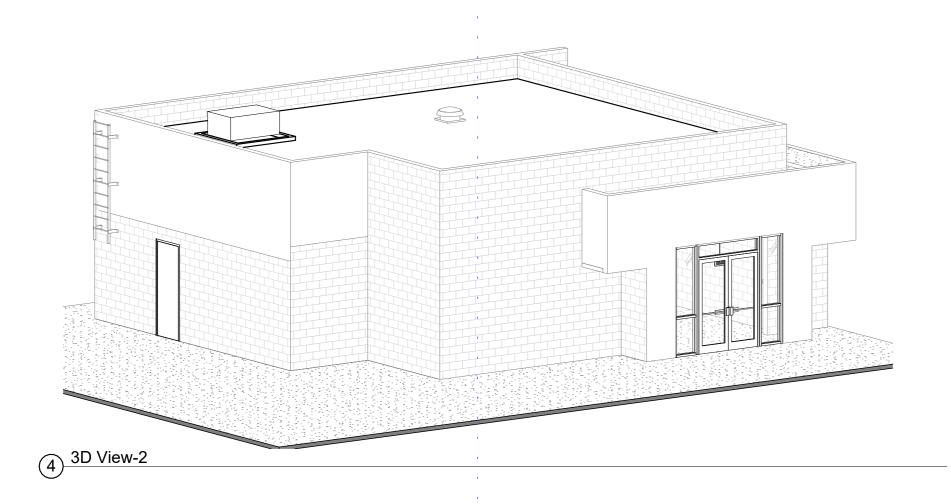

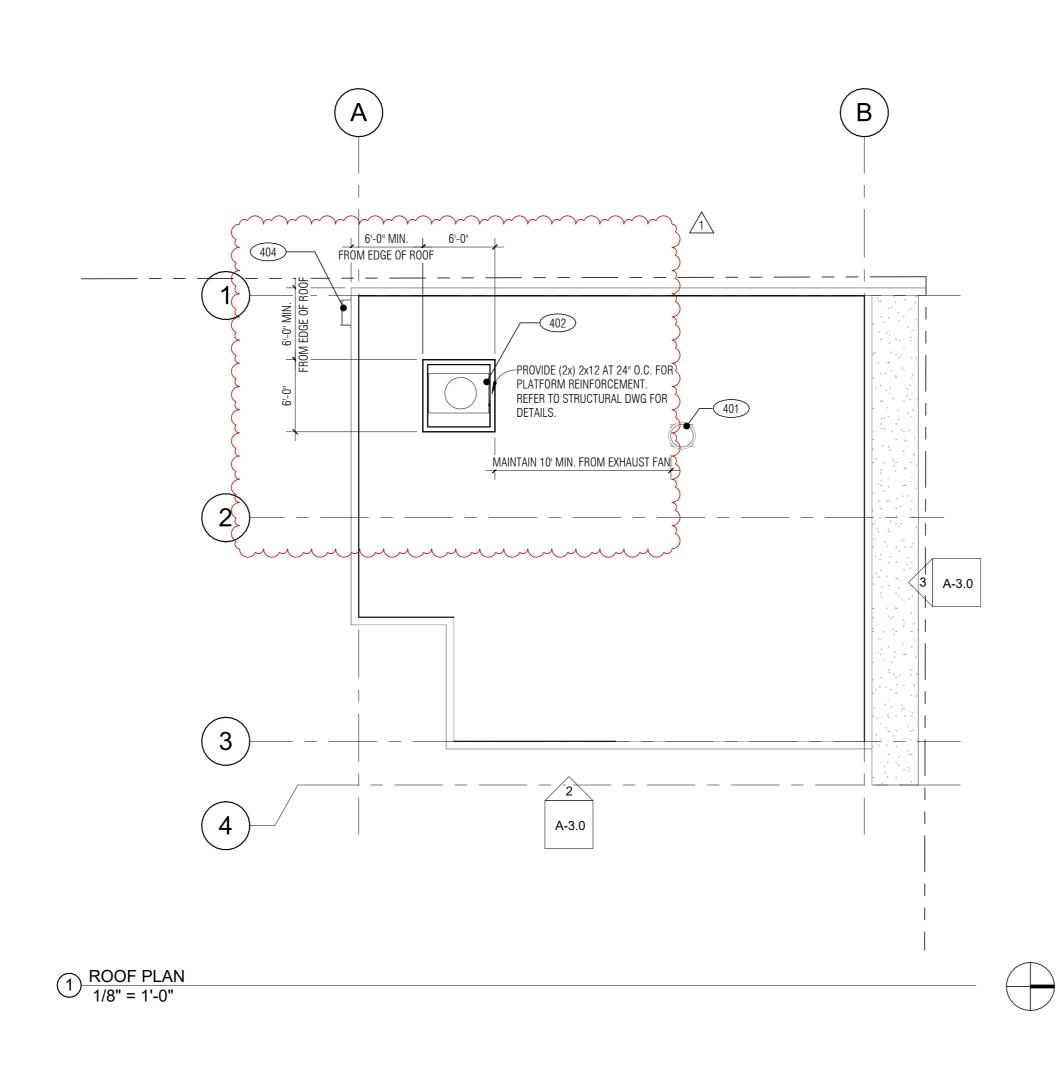



MOTIVATE GYM

TENANT IMPROVEMENT

5518 FRANKLIN AVE, HOLLYWOOD CA



	LEGE	END		SHEET NOTES		KEYNOTES	
	TAPERED INSULATION CRICKET	os	PERIMETER ROOF DRAIN WITH PARAPET OVERFLOW SCUPPER (WITHOUT CONDUCTOR HEAD)	MAINTAIN POSITIVE DRAINAGE TO EXISTING ROOF DRAIN LOCATIONS. WHERE NEW WORK CONFLICTS WITH EXISTING DRAINAGE FLOW, PROVIDE CRICKETS AROUND OBSTRUCTIONS COMPATIBLE WITH EXISTING ROOF MEMBRANE ASSEMBLY AND SHEET METAL AND AIR CONDITIONING CONTRACTORS NATIONAL ASSOCIATION [SMACNA] STANDARDS FOR FLASHING FABRICATION AND ASSEMBLY. CRICKETS SHALL SLOPE 3/8" / FOOT MIN.	NO. 401 402	DESCRIPTION EXISTING ROOF VENTILATION TO REMAIN. NEW 5-TON HVAC UNIT TO BE PLACED AT THIS LOCATION WITH A 6'X6' PLATFORM. REFER TO STRUCTURAL	-
	ROOF HATCH	OS-CH	PARAMETER ROOF DRAIN WITH PARAPET OVERFLOW SCUPPER	2. SEE ENGINEERING DRAWINGS FOR ROOF PENETRATION ROUGH OPENING DIMENSIONS, EDGE OF DECK DIMENSIONS AND NEW FRAMING AROUND NEW ROOF PENETRATIONS WHERE OCCUR.	404	DWG FOR PLATFORM DETAILS.REFER TO PRODUCT SPECIFICATION FOR EXACT DIMENSIONS AND WEIGHT. EXISTING ROOF LADDER TO REMAIN.	
	EXHAUST FAN		(WITH CONDUCTOR HEAD)	 WHERE EXISTING CONDITIONS ARE DOCUMENTED, THEY ARE PROVIDED FOR THE PURPOSE OF COORDINATION ONLY AND DO NOT INCLUDE CONCEALED CONDITIONS OR EXISTING NON-COMPLIANT WORK. WHERE EXISTING MECHANICAL EQUIPMENT IS SHOWN TO BE REMOVED, PATCH AND REPAIR ROOFING MEMBRANE WITH NEW, COMPATIBLE 			
	PATH OF 2" BUILDING EXPANSION JOINT		ROOF ACCESS LADDER (WITHOUT FALL PROTECTION CAGE)	MATERIALS TO MATCH EXISTING. MATCH EXISTING UL RATING. 5. CONTRACTOR SHALL VERIFY SIZES AND LOCATIONS OF MECHANICAL/ROOF MOUNTED EQUIPMENT PLATFORMS, HOUSEKEEPING PADS, DRAIN LOCATIONS, POWER FEEDS, SEISMIC RESTRAINT AND INSTALLATION REQUIREMENTS WITH EQUIPMENT MANUFACTURER'S PRIOR TO START			
	PATH OF 1" BUILDING EXPANSION JOINT		ROOF-TO-ROOF ACCESS LADDER	OF WORK. 6. COORDINATE PENETRATIONS THROUGH ROOF WITH STRUCTURAL, PLUMBING, MECHANICAL, AND ELECTRICAL. PROVIDE FLASHING AT PENETRATIONS PER SMACNA DETAILS. 7. ROOF CURBS FOR MECHANICAL UNITS AND EQUIPMENT TO BE FURNISHED, INSTALLED AND FLASHED BY CONTRACTOR, U.O.N.			
0	VENT THROUGH ROOF	LX-X	EXTERIOR BUILDING MTD LIGHTING	CONTRACTOR WILL COORDINATE, LOCATE AND INSTALL DRAINS AND CURBS. CONTRACTOR SHALL FLASH AND SEAL DRAINS, ROOF PENETRATIONS, ROOF EDGES, AND TERMINATIONS AS PART OF THIS CONTRACT INCLUSIVE OF WARRANTY AS LISTED IN THE PROJECT MANUAL.			
RD ORD O	ROOF DRAIN WITH OVERFLOW DRAIN		ROOF WALKWAY PADS	9. ROOF PLAN AND DETAILS ARE FOR GENERAL DESIGN INTENT. CONTRACTOR TO SUBMIT COMPLETE SHOP DRAWINGS SHOWING CONSTRUCTION DETAILS AND LAYOUTS FOR A COMPLETE JOB ADHERING TO MANUFACTURER'S WARRANTIES. 10. SLOPE ROOF AREAS AT A MIN. OF 1/4" PER FOOT, UON. PROVIDE SLOPES OF 3/8" PER FOOT MINIMUM IN LOCATIONS OF HEAVY RAINFALL. 11. CONCEALED WOOD BLOCKING SHALL BE P.T. POSITIVELY SECURED TO DECKING AND SUBSTRATE WITH ANCHOR BOLTS.			
RD	ROOF DRAIN		ROOF DECK PAVER SYSTEM	12. UTILIZE APPROVED METAL WALL FLASHING AND COUNTER FLASHING ON BACKSIDE OF ALL PARAPETS WITH A HEIGHT OF 2'-0" OR GREATER. 13. SHEET METAL APPLICATIONS SHALL BE INSTALLED PER SMACNA CURRENT EDITION APPROVED DETAILING, INCLUDING (BUT NOT LIMITED TO) COPING, STEP-FLASHING, METAL WALL FLASHING, ROOF PENETRATION FLASHING, STANDING SEAM METAL ROOFS, GUTTERS, SCUPPERS,			
ORD ○	OVERFLOW DRAIN		NOO! BEGINNER OF OF EM	GUTTER STOPS, CONDUCTOR HEADS, AND MISC. JOINTS BETWEEN SHEET METAL MEMBERS. 14. RIGID INSULATION USED IN ROOF ASSEMBLIES SHALL MEET THE REQUIREMENTS OF UL 1256 AND FMG 4450. 15. METAL GAUGES SHALL COMPLY WITH ANSI/SPRI ES-1 REQUIREMENTS FOR SHOP FORMED METAL COPINGS.			
□ DS □ DS	DOWNSPOUT			16. OBJECTS GREATER THAN 24" IN WIDTH ACROSS SLOPE SHALL HAVE CRICKETS TO DIVERT WATER. 17. INSTALL ROOF DRAIN LEADERS, FROM DRAIN ASSEMBLY TO DRAIN CHASE, AT MAXIMUM ALLOWABLE ELEVATIONS WHILE MAINTAINING			
	DOWNSPOUT TO SPLASHBLOCK			REQUIRED SLOPE. 18. ANYWHERE EXPOSED FASTENERS ARE USED IN THE ROOFING SYSTEM, COPING SYSTEM, EXPANSION JOINT SYSTEM, OR FLASHING SYSTEM, THEY SHALL UTILIZE SEALING WASHERS.			
	THROUGH PARAPET ROOF SCUPPER WITH COLLECTION BOX			19. PROVIDE WALKWAY PADS ON ROOF FROM ROOF ACCESS POINTS TO AROUND MECHANICAL EQUIPMENT.			
0 }	GUTTER, SLOPE TO DRAIN						
	MECHANICAL EQMT SCREEN						

PLAN CHECK CORRECTION DELTA 1 Owner Approval MOTIVATE STUDIO

Job No. 1/8" = 1'-0"

ROOF PLAN
Title
A-4.0
Sheet